




CANBERRA	PROJECT DETAIL		4 6		AREAS		REV	DESIGN PHASE	DATE	DRAWING NAM	E		
			Proposed Structure GFA - Single Storey - Class 1 6 Proposed Structure GFA - Class 10 1.		63.92m2 P1.9 PROJECT PLAN		19/10/2023	FLOOR PLAN - FURNITURE			IRF		
GRANNY FLAT	Block № 32	+ Dungowan Street	i, Hawkei /le	7 2014	Proposed Roof Area - Class 1 Proposed Roof Area - Class 10	76.97 m2 19.10 m2	CUSTOMER APPR	ROVAL		'	LOOKII	2/11/ 1/01/11/11/	
BUILDERS	Section № 24				Block Area	747.00 m2			-	DRAWING SCALE	CHEET CIZE	DRAWING NUMBER	CHECKLIST NUMBER
	ADCUITECT	DESIGNER	TENADI ATE	DI OCK TYPE	Actual Block Ratio Actual POS [(GFA + Gar. GFA + Dr'way) - Block area]	38.47% 380.08 m2					SHEET SIZE	DRAWING NUMBER	
PROJECT TYPE	ARCHITECT		TEMPLATE	BLOCK TYPE	Minimum Private Open Space (Block area x 0.60)	448.20 m2				1:50	A3	4	1101
CANBERRA GRANNY FLAT BUILDERS	LIKA	MONICA	v.19.4	LARGE	Site Coverage (LARGE   max 40%)	45.56 %/	NAM	E SIGNATURE	DATE				

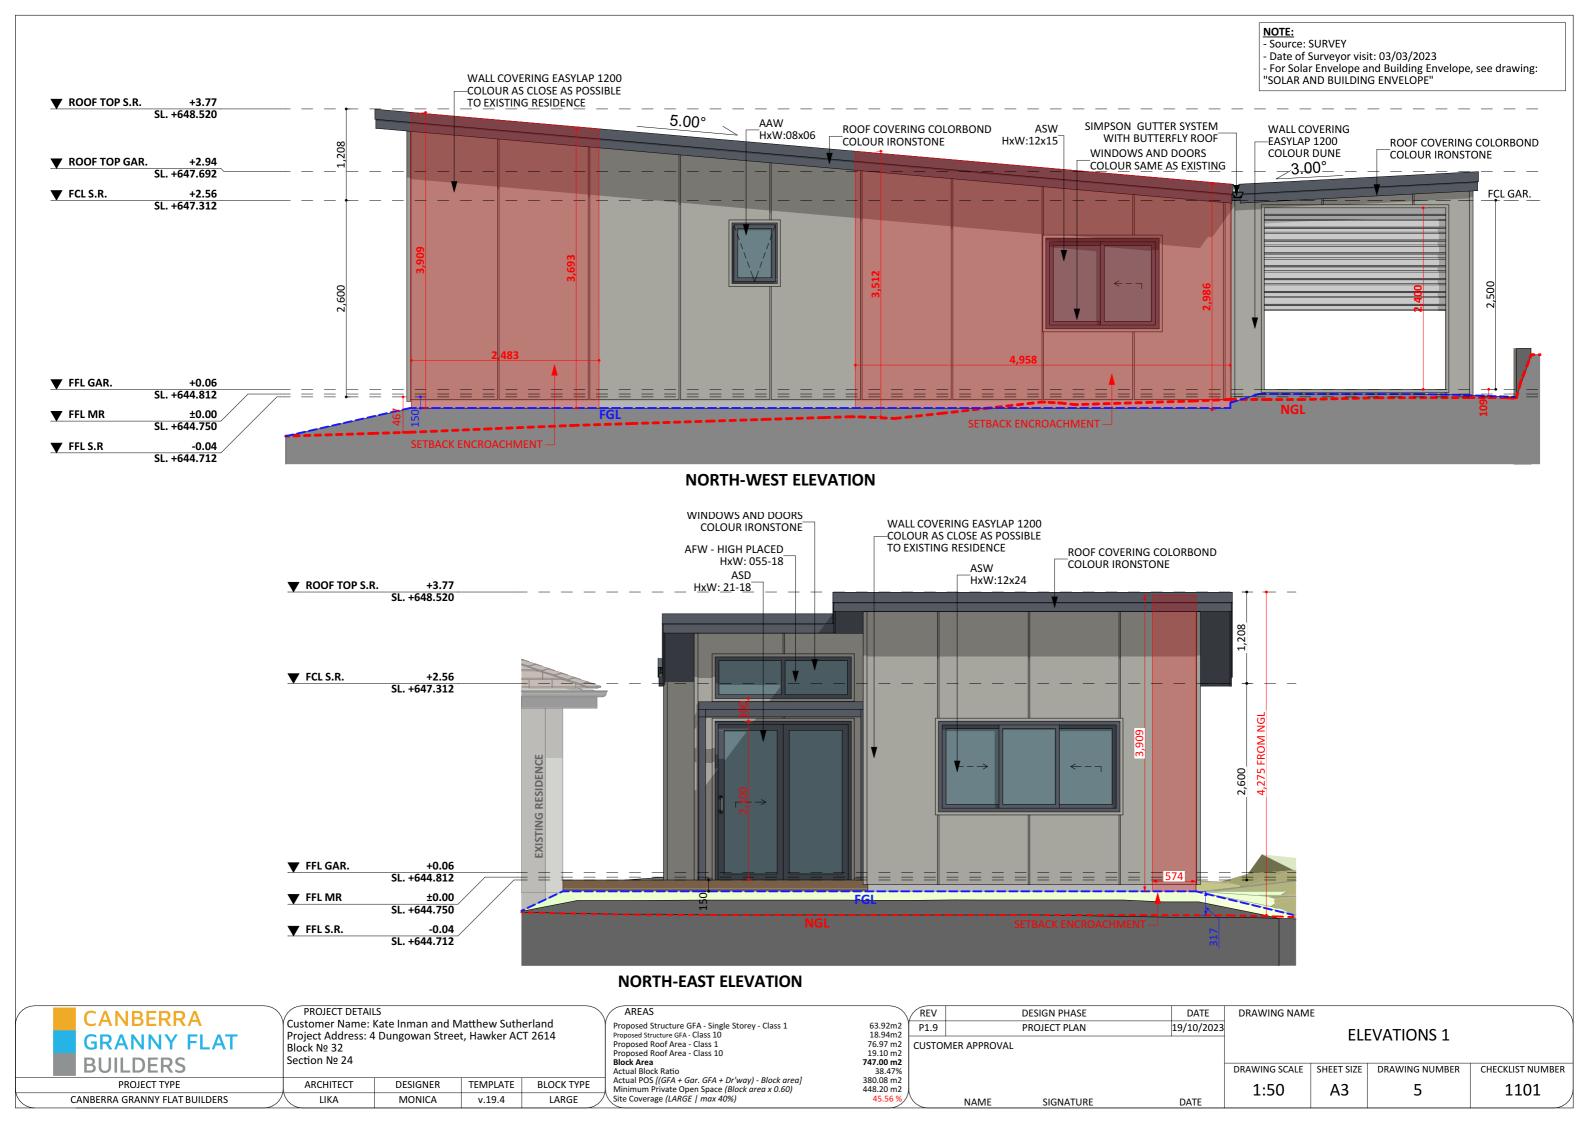

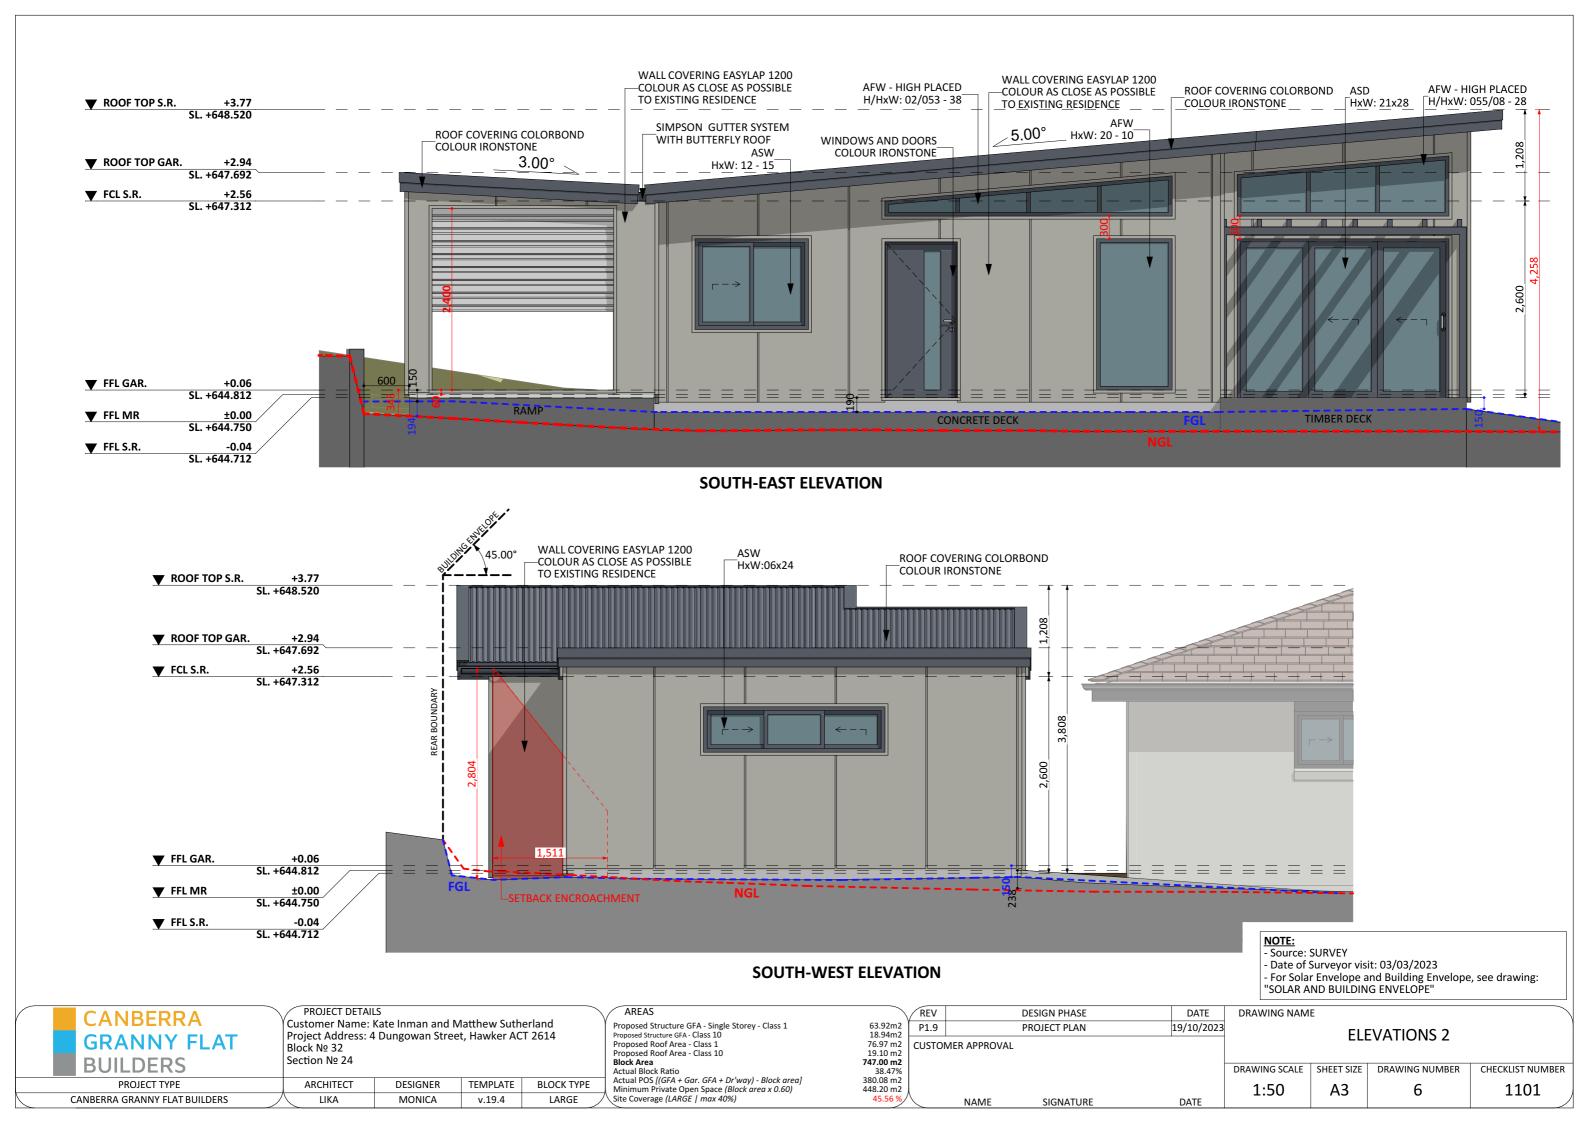

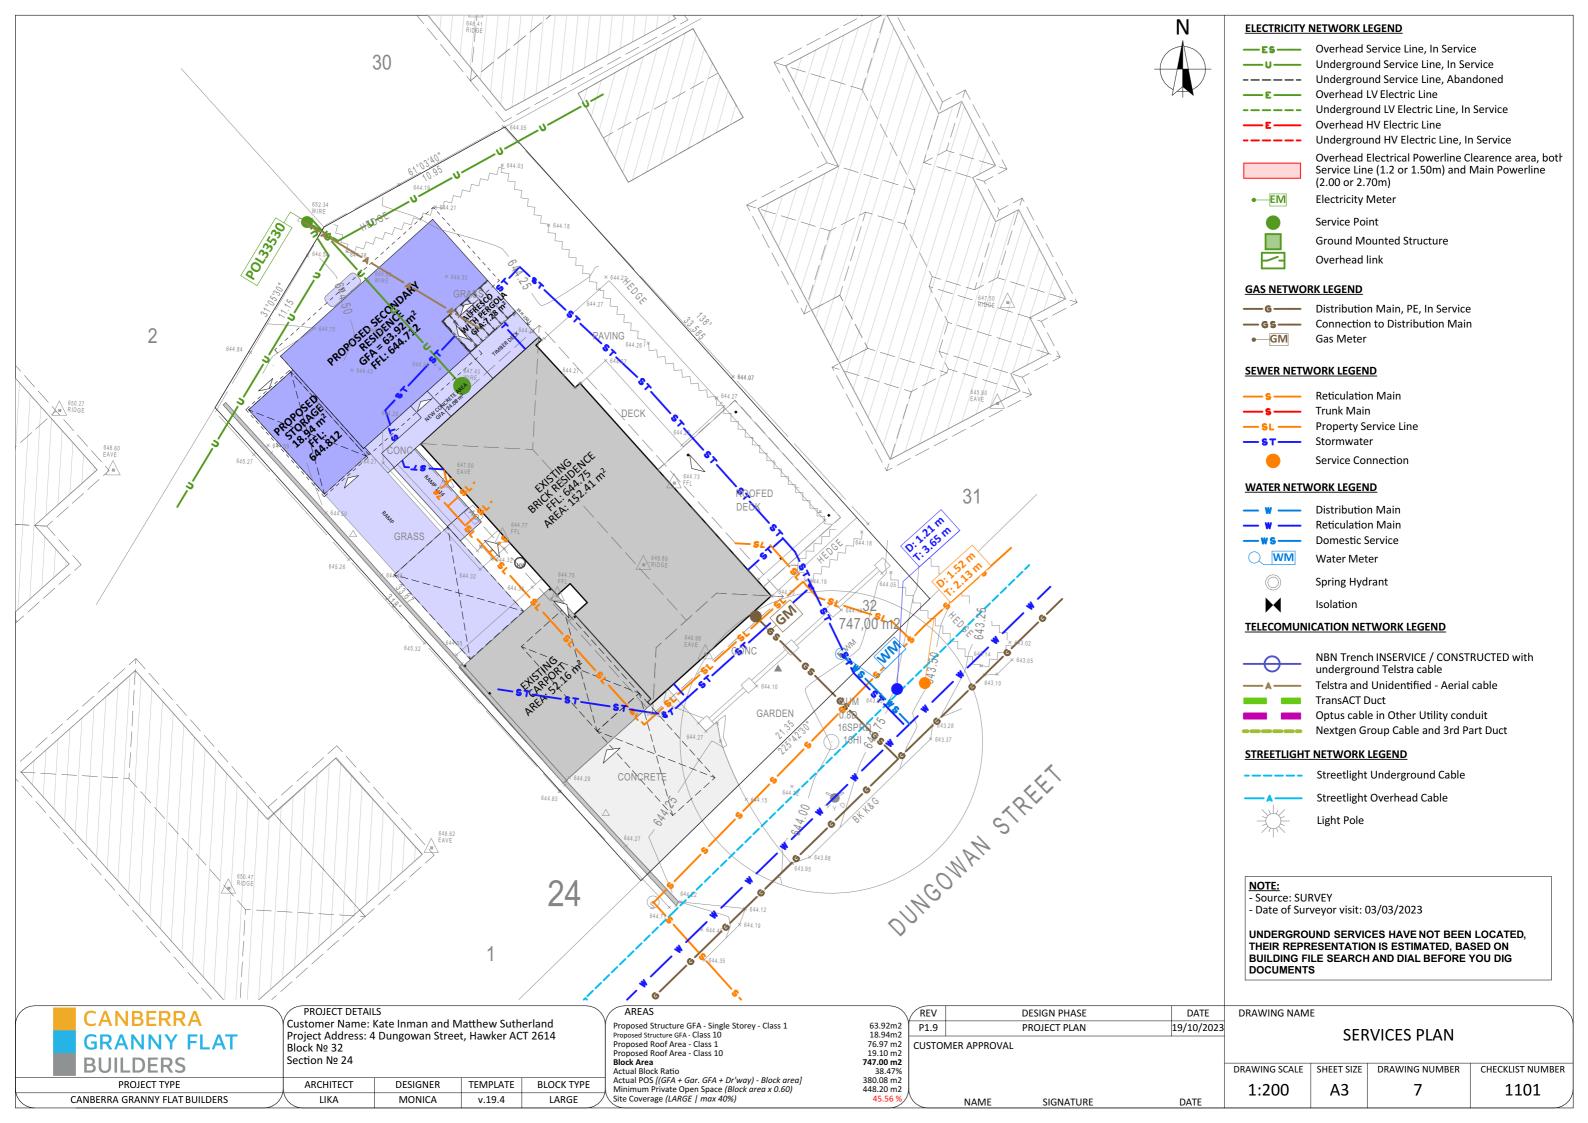





Section № 24

PROJECT TYPE ARCHITECT DESIGNER TEMPLATE BLOCK TYPE
CANBERRA GRANNY FLAT BUILDERS LIKA MONICA v.19.4 LARGE

AREAS

Proposed Structure GFA - Single Storey - Class 1
Proposed Structure GFA - Class 10
Proposed Roof Area - Class 1
Proposed Roof Area - Class 10
Block Area
Actual Block Ratio
Actual POS ((GFA + Gar. GFA + Dr'way) - Block area)
Minimum Private Open Space (Block area x 0.60)
Site Coverage (LARGE | max 40%)

REV DESIGN PHASE DATE


63.92m2
18.94m2
76.97 m2
19.10 m2
747.00 m2
38.47%
380.08 m2
448.20 m2
45.56 %


NAME SIGNATURE DATE

3D ELECTRICAL CABLES - POWERLINE CLEARANCE

DRAWING SCALE SHEET SIZE DRAWING NUMBER CHECKLIST NUMBER

A3 8 1101

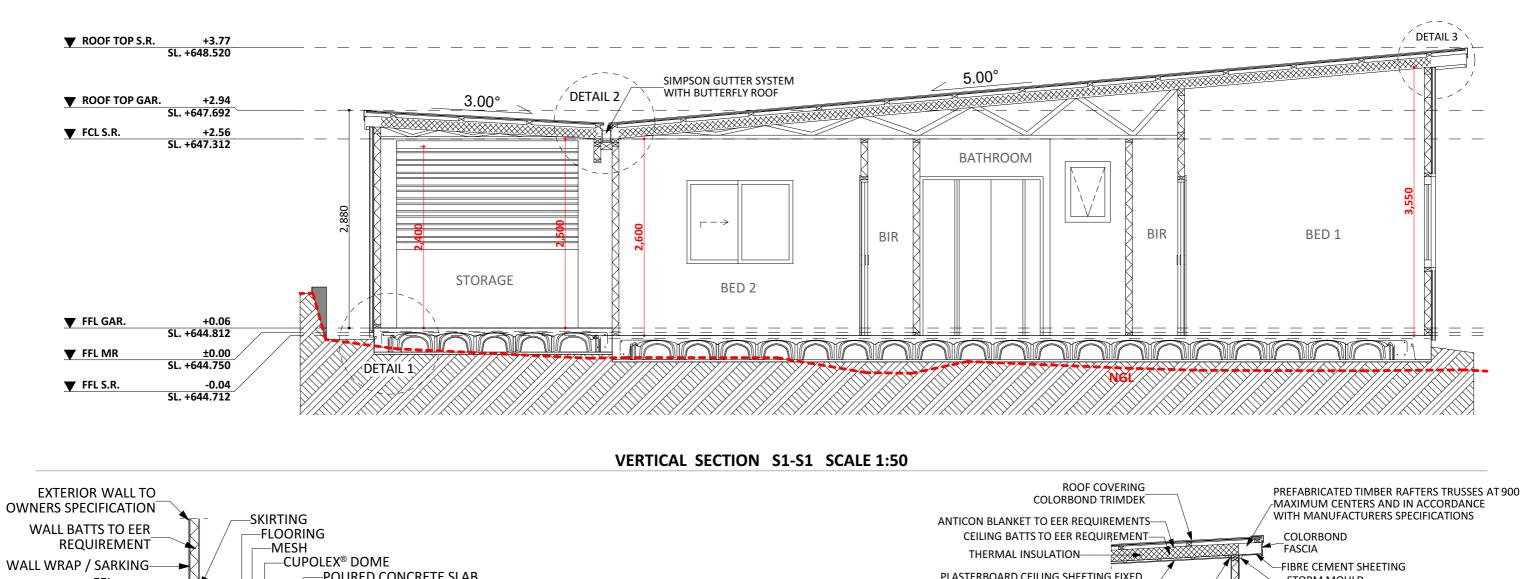

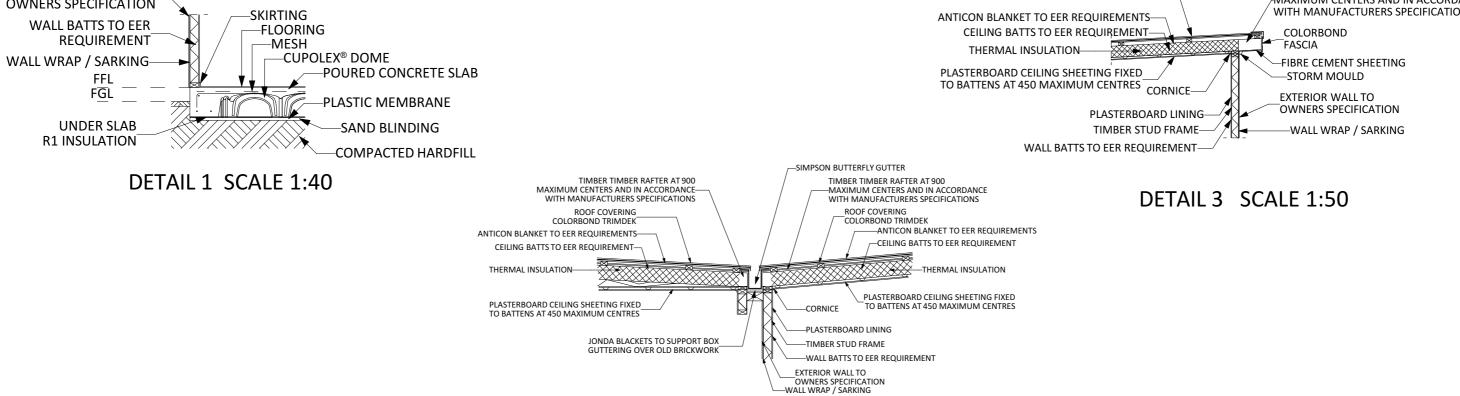

CANBERRA GRANNY FLAT BUILDERS	PROJECT DETAIL Customer Name: Project Address: 4 Block № 32 Section № 24	Kate Inman and N			AREAS Proposed Structure GFA - Single Storey - Class 1 Proposed Structure GFA - Class 10 Proposed Roof Area - Class 1 Proposed Roof Area - Class 10 Block Area Actual Block Ratio	63.92m2 18.94m2 76.97 m2 19.10 m2 747.00 m2 38.47%	-	DESIGN PHASE PROJECT PLAN	DATE 19/10/2023	DRAWING NAMI	VERT	TICAL SECTION  DRAWING NUMBER	CHECKLIST NUMBER
PROJECT TYPE	ARCHITECT	DESIGNER	TEMPLATE	BLOCK TYPE	Actual POS [(GFA + Gar. GFA + Dr'way) - Block area] Minimum Private Open Space (Block area x 0.60)	380.08 m2 448.20 m2				1:50, 1:40	А3	9	1101
CANBERRA GRANNY FLAT BUILDERS	LIKA	MONICA	v.19.4	LARGE	Site Coverage (LARGE   max 40%)	45.56 %	NAME	SIGNATURE	DATE	1.50, 1.40	7	7	1101

DETAIL 2 SCALE 1:40

### Adaptable Housing to AS 4299 Features to be included post adaptation

3. A continuous accessible path of travel is to be provided from street frontage and vehicle parking to entry complying with AS1428.1

11. Letterboxes to be on hard standing area connected to accessible path of travel

### Private car accommodation

14. Car parking space or garage min. area 6.0 m x 3.8 m post adaption.

### Accessible Entry

- 20. Accessible entry to be provided.
- 22. Accessible entry to be level (i.e. max. 1:40 slope)
- 23. Treshold to be low-level.
- 24. Landing to enable wheelchair maneuverability
- 25. Accessible entry door to have 850 mm min. clearance
- 26. Weatherproofed entry door
- 27. Door level handles and hardware to AS 1428.1.
- 28. Provision for combined door/security door

- 32. Internal doors to have 820 mm min clearance.
- 33. Internal corridors min. width of 1000 mm.
- 34. Provision for compliance with AS 1428.1 for door approaches.

### Living and Dining room

- 36. Provision for circulation space of min. 2250 mm diameter
- 38. Telephone adjacent to GPO
- 41. Potential illumination level min. 300 lux

- 42. Minimum width 2.7 m (1550 mm clear between benches)
- 43. Provision for circulation at doors to comply with AS 1428.1
- 45. Refrigerator adjacent to work surface
- 47. Kitchen sink bowl max. 150 mm deep
- 48. Tap set capstan or lever handles or lever mixer.
- 49. Tap set located within 300 mm of front of sink
- 51. Cooktops to include either front or side controls with raised crossbars.
- 52. Cooktops to include isolating switch.
- 59. GPOs to comply with AS 1428.1. At least one double GPO within 300 mm of front of work surface.
- 60. GPO for refrigerator to be easily reachable when the refrigerator is in operating position
- 61. Slip-resistant floor surface.

# mm above floor

### **Bedroom**

62. At least one bedroom of area sufficient to accommodate gueen size bed and wardrobe and circulation space requirements of AS 1428.2

- 75. Provision for bathroom area to comply with AS 1428.1. 76 Slip-resistant floor surface.
- 77. Shower recess- no hob. Minimum size 1160 x 1100 to comply with AS 1428.1.
- 78. Shower area waterproofed to AS 3740 with floor to fall to waste.
- 79. Recessed soap holder.
- 80. Shower taps positioned for easy reach to access side of shower sliding track.
- 81. Shower waste min. 80 mm diameter
- 82. Provision for adjustable, detachable hand held shower rose mounted on a
- slider grab rail or fixed hook (plumbing and wall strengthening provision)
  83. Provision for grabrail in shower (Refer to Figure 4.7) to comply with AS 1428.1
- 86. Tap sets to be capstan or lever handles with single outlet.
- 88. Provision for washbasin with clearances to comply with AS 1428.1.
- 90. Double GPO beside mirror Slip-resistant floor surface


### **Toilet**


- 92. Provision of either 'visitable toilet' or accessible toilet.
- 93. Provision to comply with AS 1428.1
- 94. Location of WC pan at correct distance from fixed walls.
- 95. Provision for grab rail zone.
- 96. Slip resistant floor surface.


- Provision for 1550mm circulation space in front or beside appliances
- Provision for automatic washing machine
- Where clothes line is provided, an accessible path of travel to the clothesline
- Double GPO power point
- Slip resistant floor surface

### **Door locks**


110. Door hardware operable with one hand, located 900-1100 mm above floor

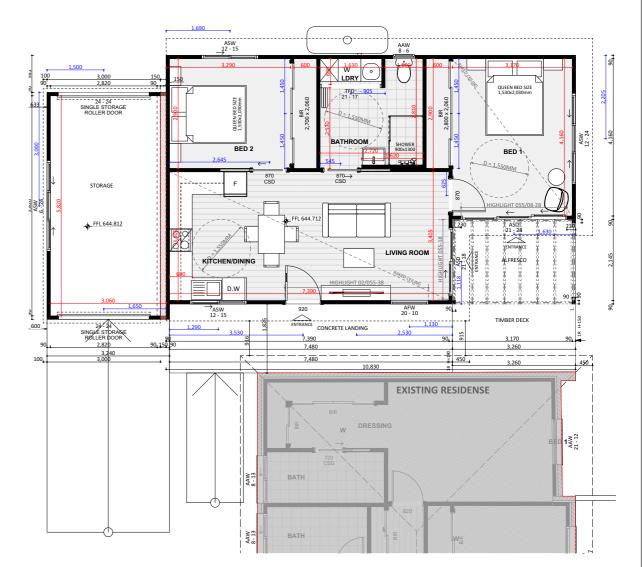


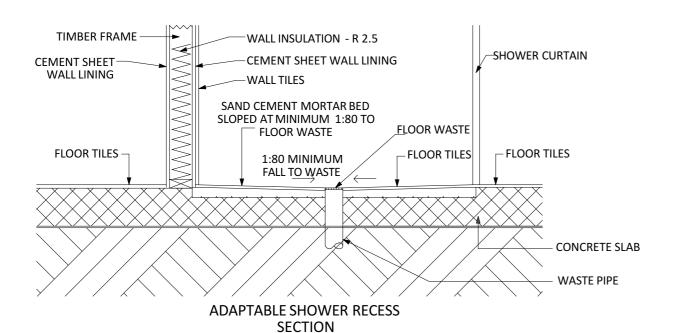


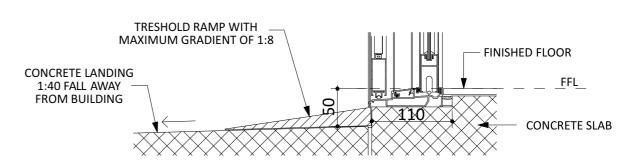



ACCESSIBLE ENTRY SECTION **ALUMINIUM SLIDING DOORS** SCALE 1:5

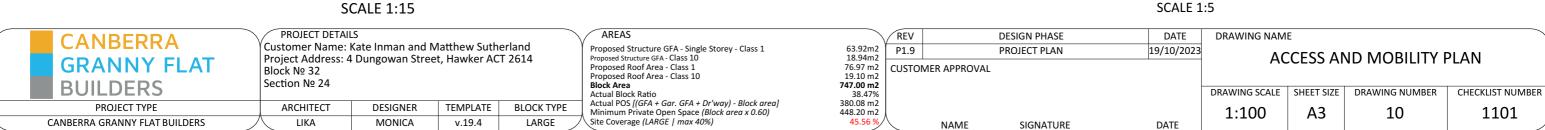


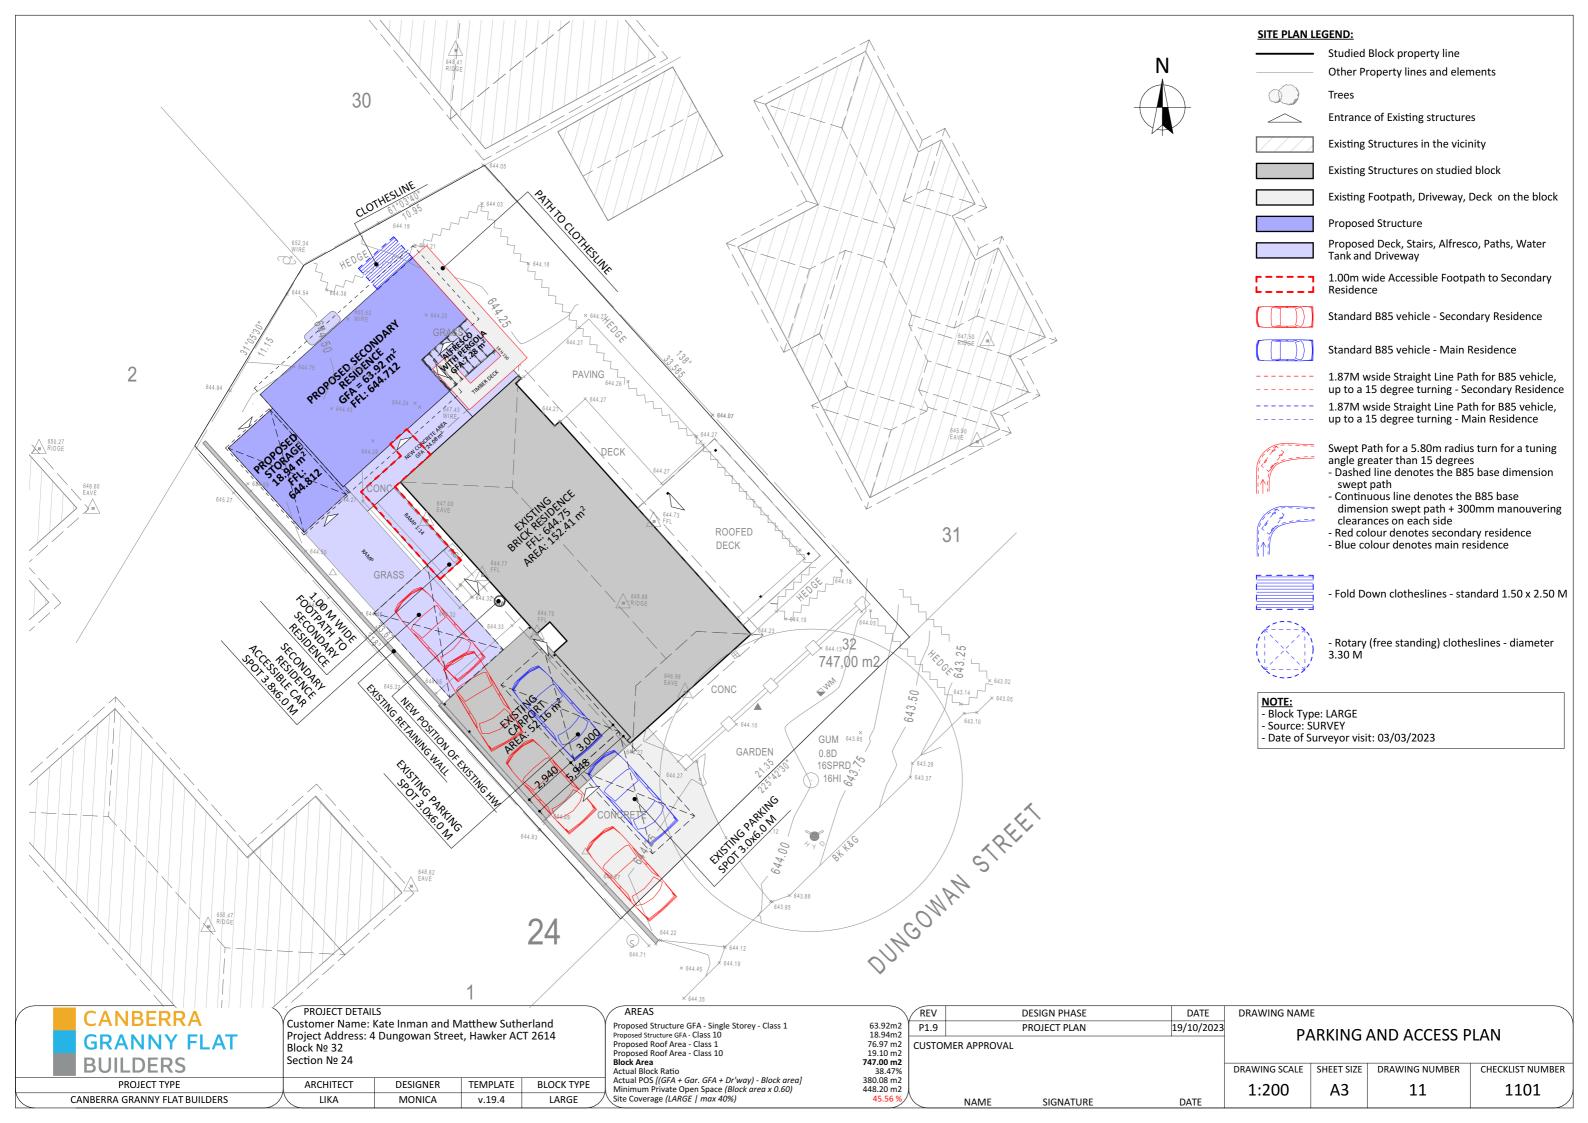


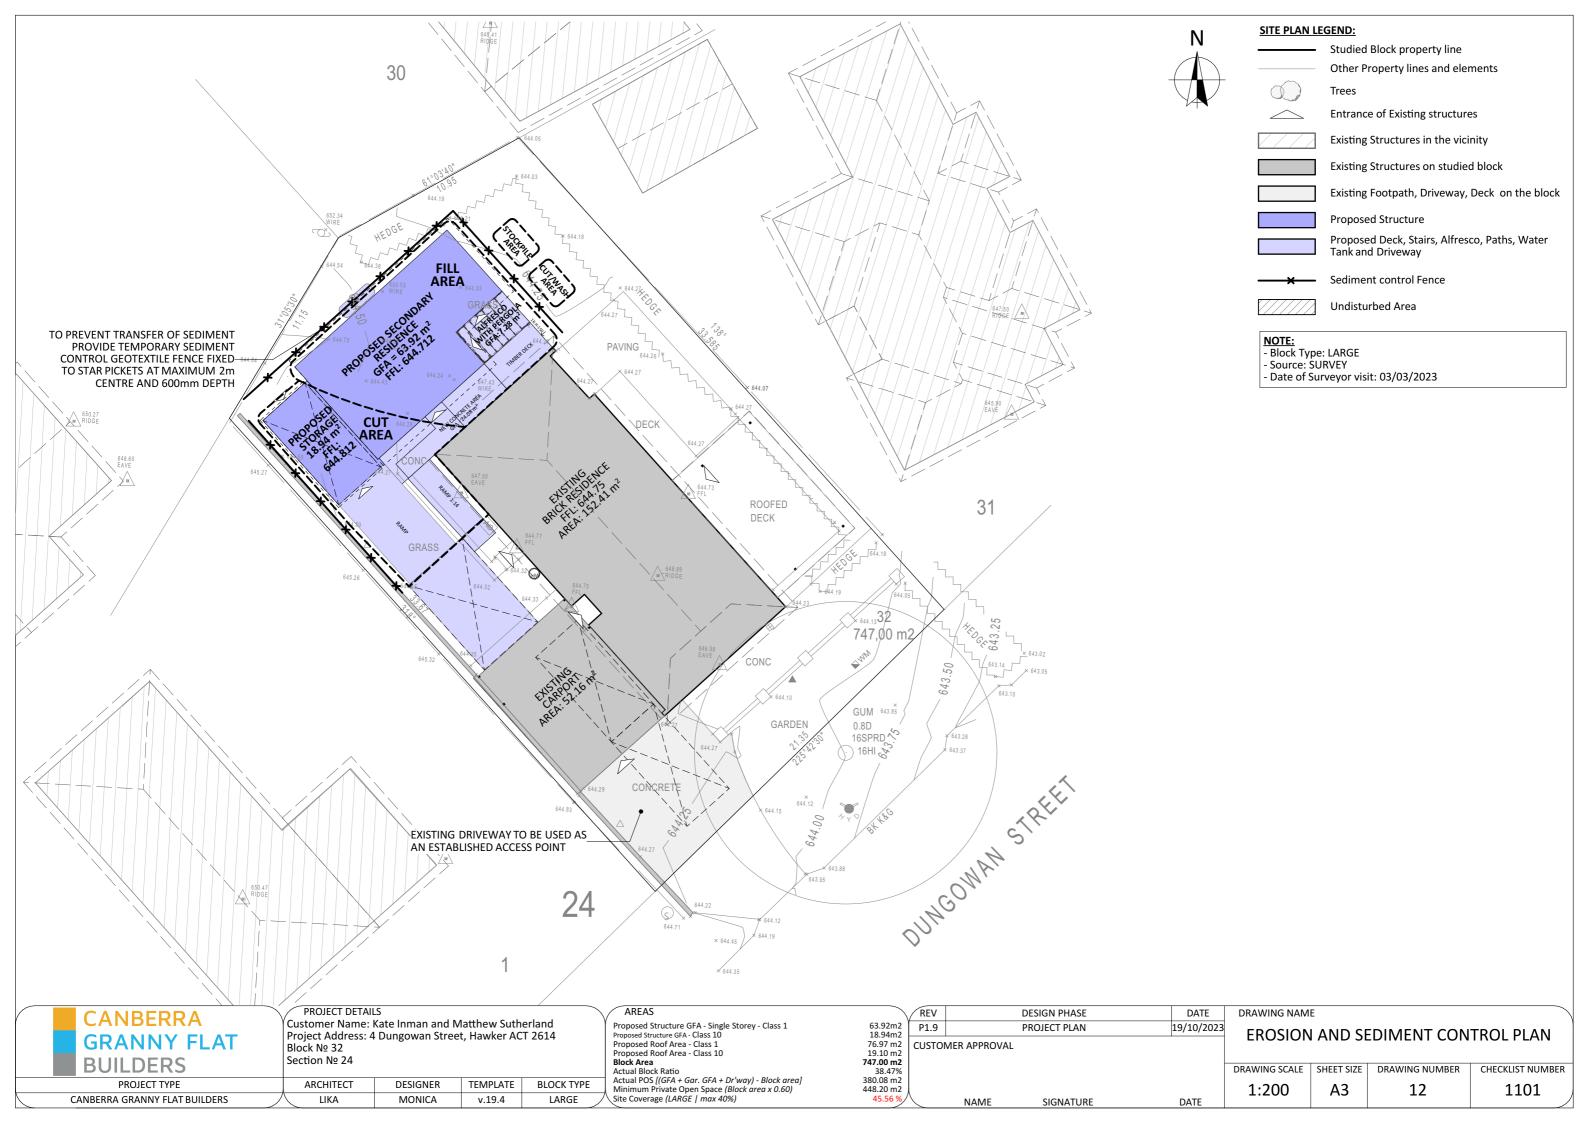

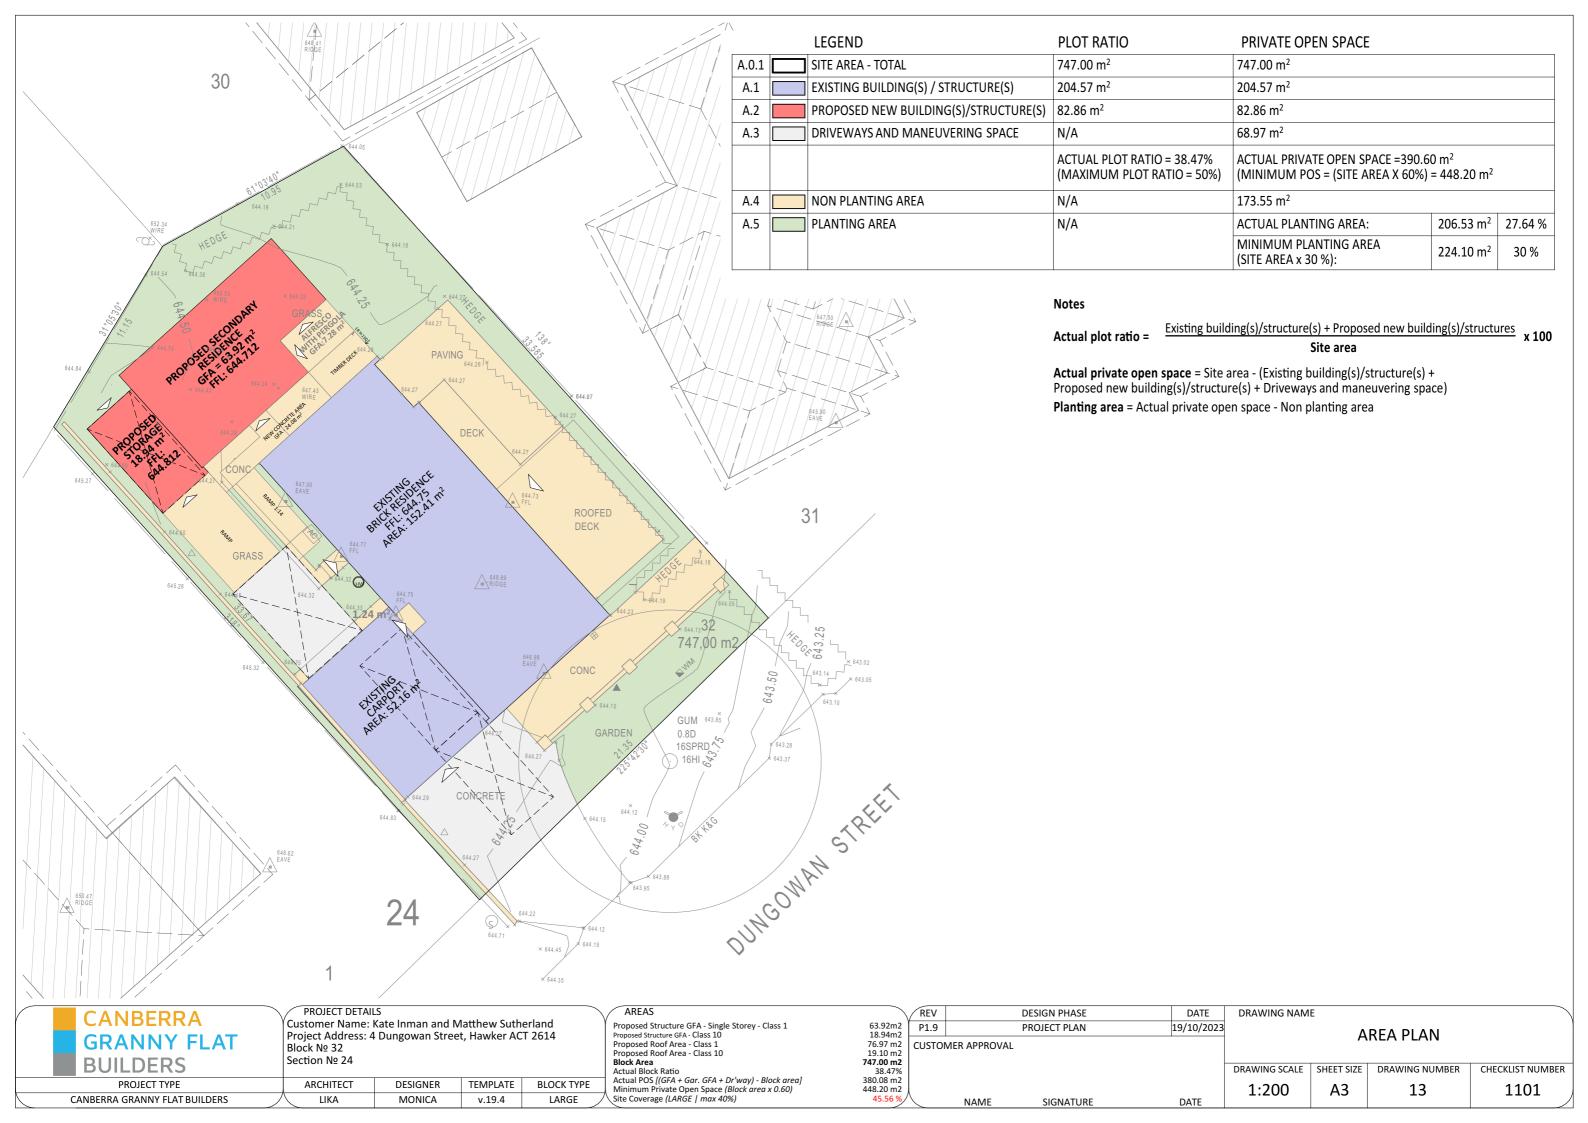

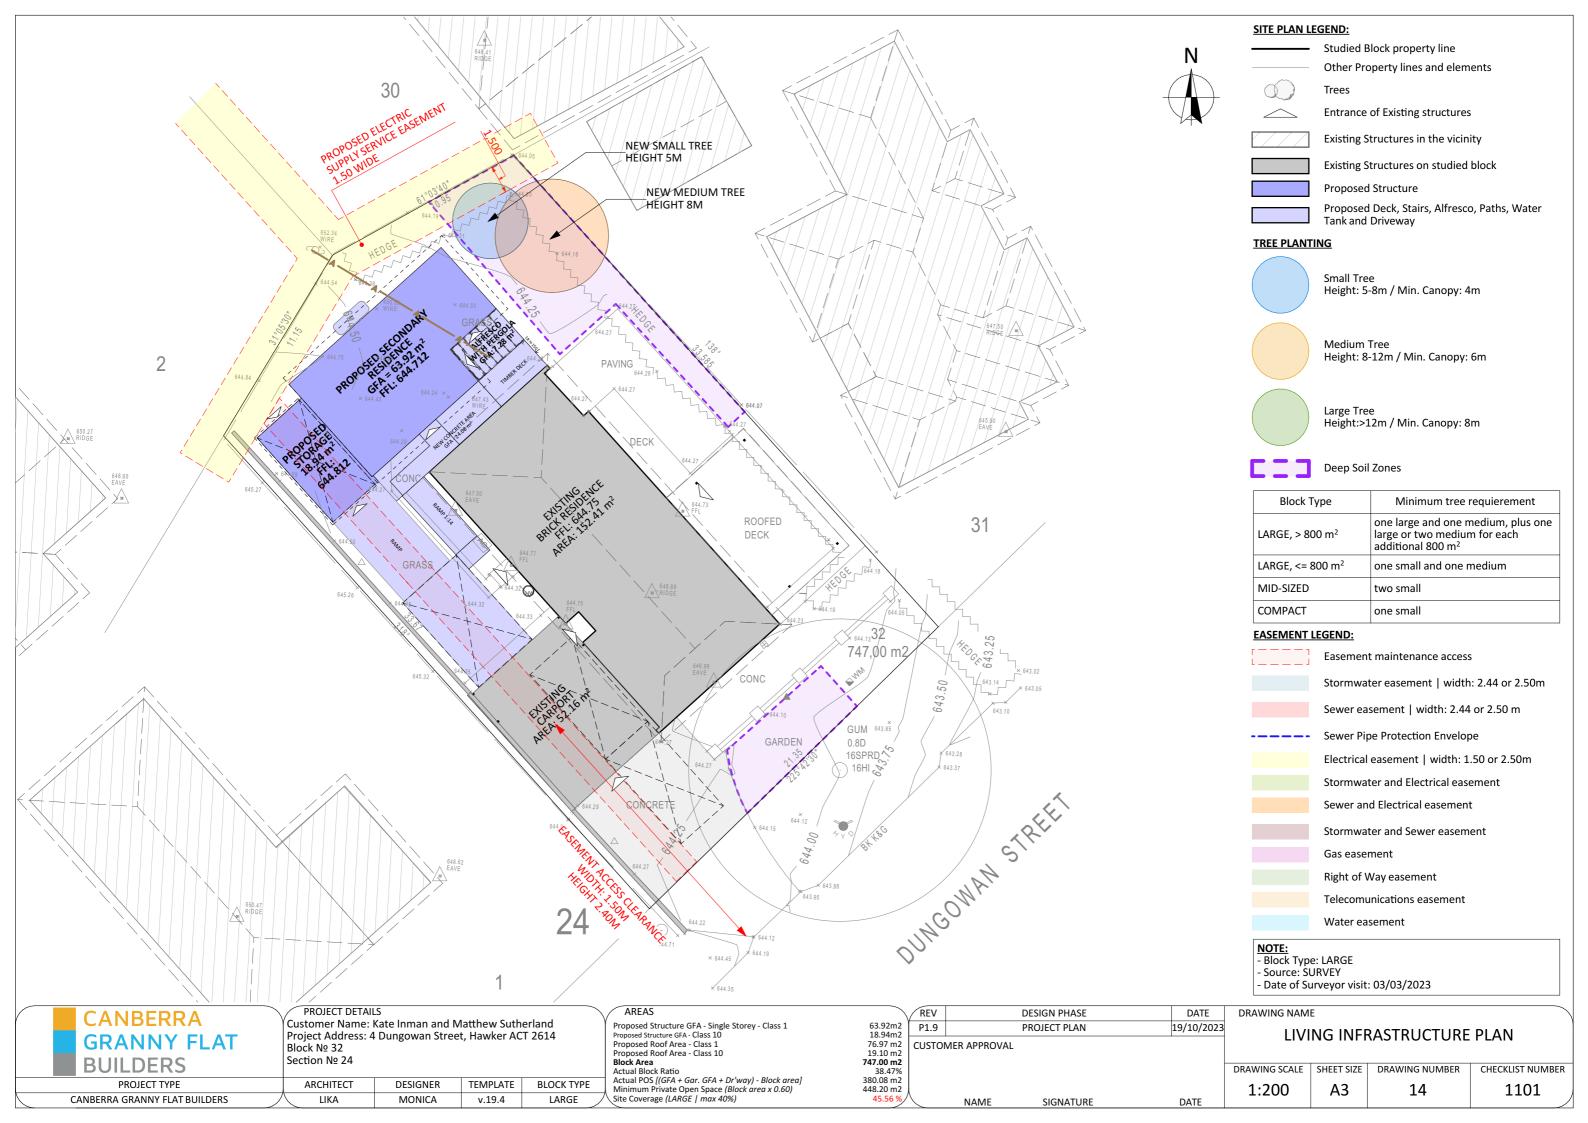

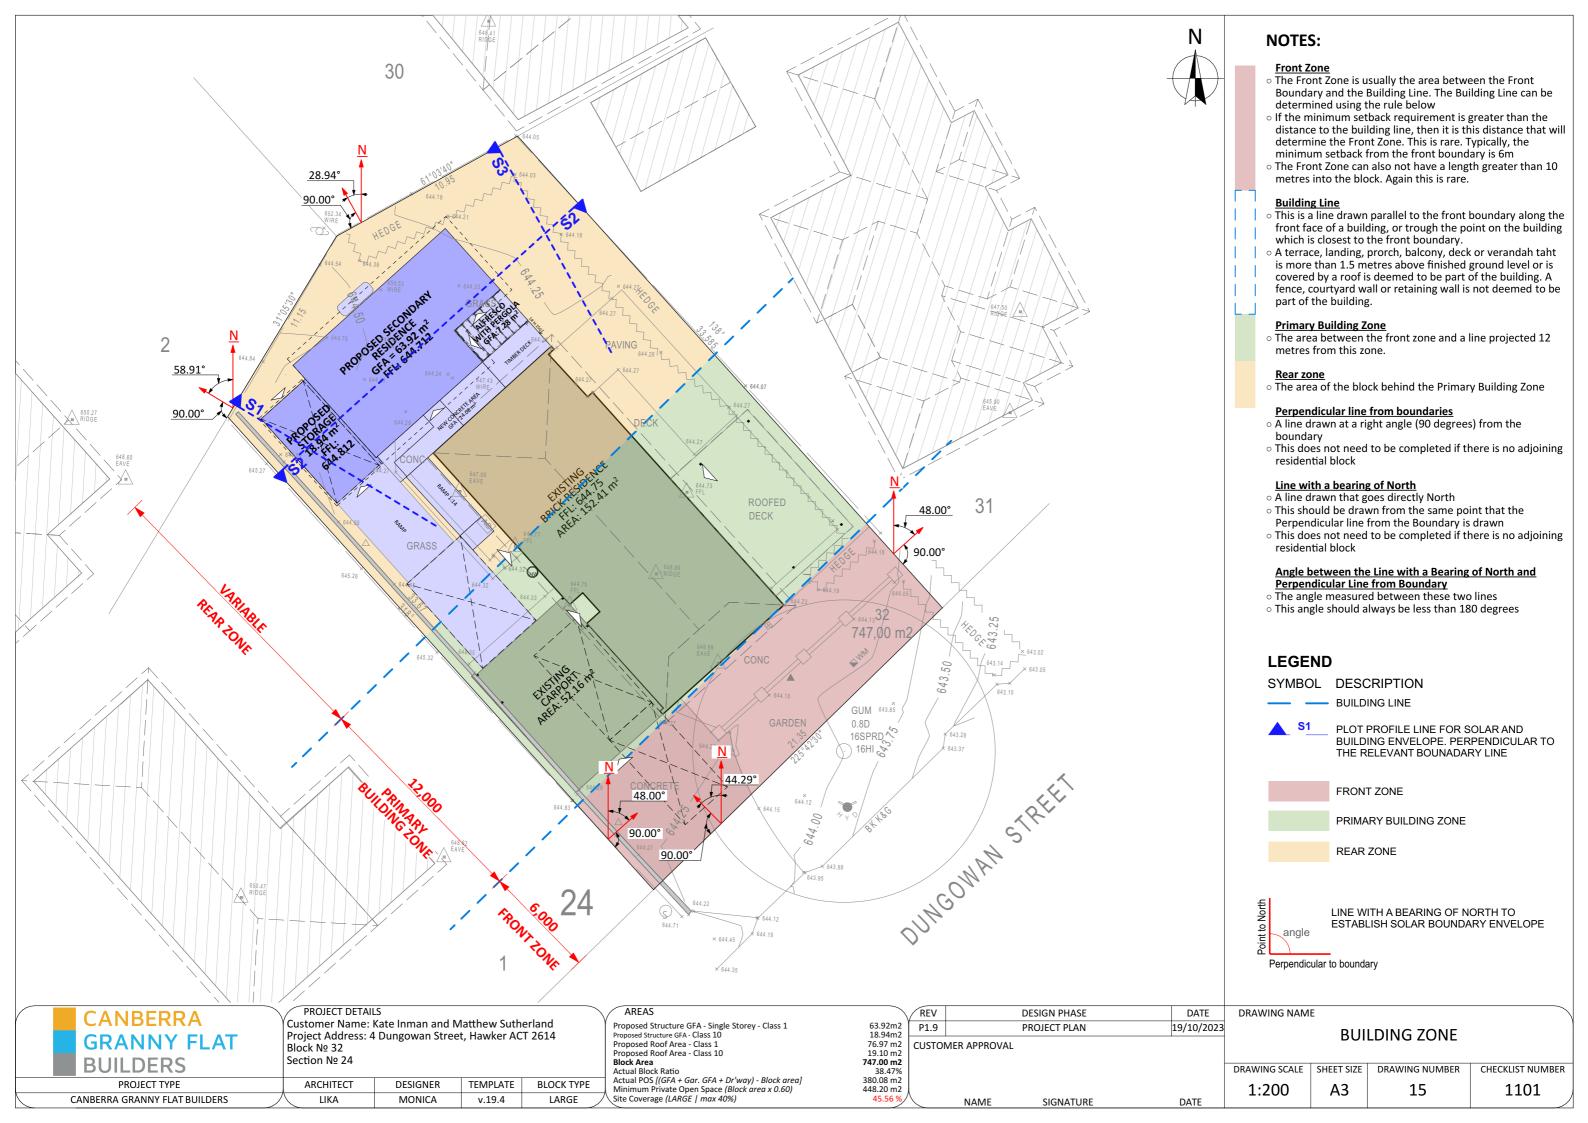

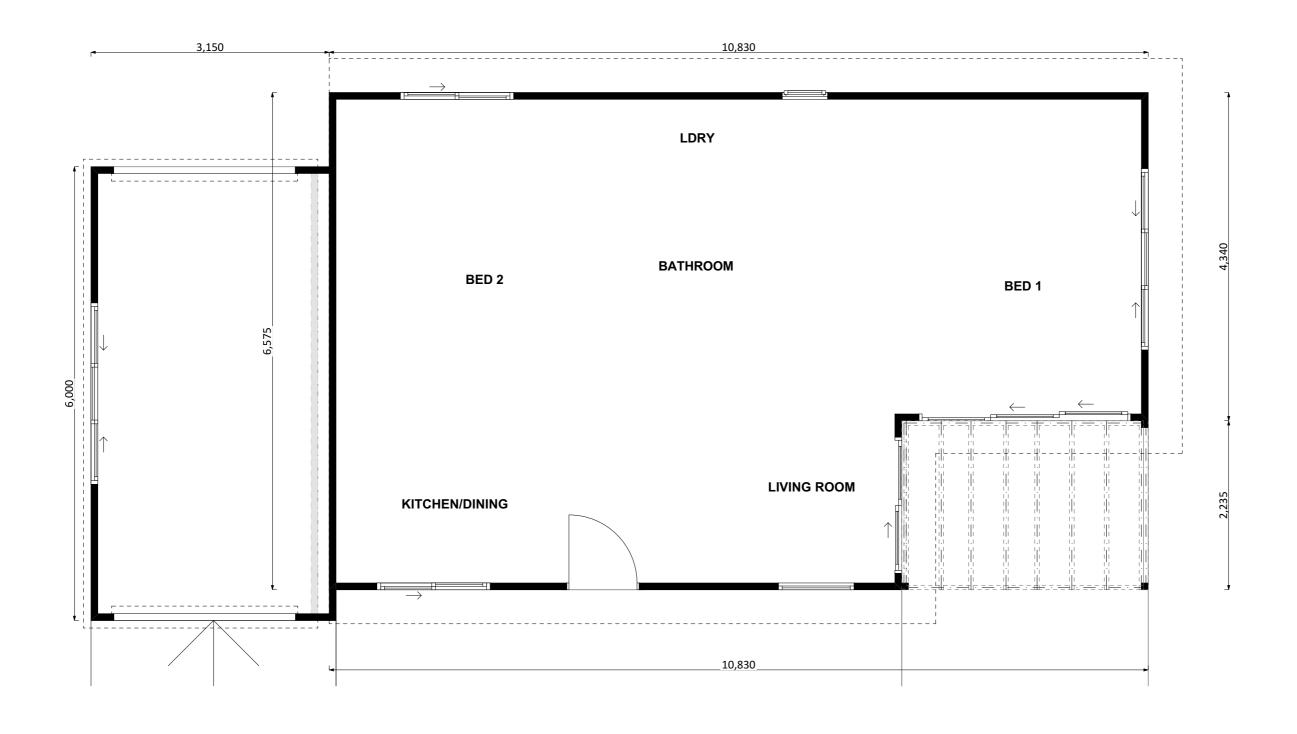



TEMPLATE

v.19.4

BLOCK TYPE

LARGE

DESIGNER

MONICA

ARCHITECT

LIKA

AREAS

Proposed Structure GFA - Single Storey - Class 1
Proposed Structure GFA - Class 10
Proposed Roof Area - Class 1
Proposed Roof Area - Class 10
Block Area
Actual Block Ratio
Actual POS [(GFA + Gar. GFA + Dr'way) - Block area]
Minimum Private Open Space (Block area x 0.60)
Site Coverage (LARGE | max 40%)

	REV		DESIGN PHASE	DATE	DF
63.92m2 18.94m2	P1.9		PROJECT PLAN	19/10/2023	
76.97 m2 19.10 m2	CUSTO	MER APPROVAL			
<b>747.00 m2</b> 38.47%					DRA
380.08 m2					
448.20 m2	l .				
45.56 %/		NAME	SIGNATURE	DATE	

PUBLIC REGISTER PLAN

DRAWING SCALE SHEET SIZE DRAWING NUMBER CHECKLIST NUMBER

1:50 A3 16 1101

# **BUILDING ENVELOPE**

- ► Large Blocks (Greater than 500m²)
- •This rule applies to side and rear boundaries
- •Building Envelope Fence Height 3.5 m
- •Angle of projection from Building Envelope Fence 45 Degrees

# ► Mid-Sized Blocks Approved after 5 July 2013 (250 m² to 500m²)

- •This rule applies to side and rear boundaries
- •Building Envelope Fence Height 3.5 m
- •Angle of projection from Building Envelope Fence 45 Degrees

# ► Mid-Sized Blocks Approved before 5 July 2013 (250 m² to 500m²)

- •For North Facing Boundaries of Adjoining Residential Blocks (see below definition)
- oBuilding Envelope Fence Height
- Primary Building Zone 2m
- Rear Zone 2m
- oAngle of Projection from Building Envelope Fence
- Primary Building Zone 45 Degrees
- Rear Zone 30 Degrees
- ONote: if we are building on the boundary there can be different rules. Consult with Plannin Approvals Manager
- •For all other boundaries of adjoining residential blocks
  - Building Envelope Fence Height
  - Primary Building Zone 4.5m
  - Rear Zone 3.5m
  - oAngle of Projection from Building Envelope Fence
  - Primary Building Zone 45 Degrees
  - Rear Zone 30 Degrees
- •For this rule: North Facing Boundary means a boundary of a block where a line drawn perpendicular to the boundary outwards is orintated between 30 degrees east of north and 20 degrees west of norht. This is only for Mid-Sized Blocks Approved before the 5 july

# **SOLAR BUILDING ENVELOPE**


# ► Large Blocks if Approved before 5 July 2013


- •The Solar Building Envelope Rule applies to any Northern Boundary of an adjoining residential block.
- •Height of the Solar Fence is:
- oIn the Ffront and Primary Building Zone 2.4m
- oOn all other parts of the boundary 1.8m


## ► All Blocks if Approved after 5 July 2013

- •The Solar Building Envelope Rule applies to any Northern Boundary of an adjoining residential block
- •Height of the Solar Fence is:
  - oIn the Ffront and Primary Building Zone 3m
  - oOn all other parts of the boundary 2.3m

Aspect of northern boundary (bearing of line drawn perpendicular to the boundary)	Angle (X)
North 0° to <10° East	31°
North 0° to <10° West	
North 10° to <20° East	32°
North 10° to <20° West	
North 20° to <30° East	34°
North 20° to <30° West	
North 30° to <40° East	36°
North 30° to <40° West	
North 40° to 45° East	39°
North 40° to 45° West	

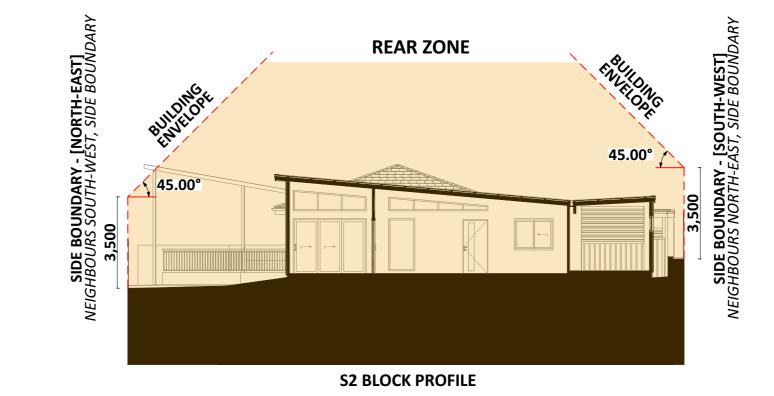

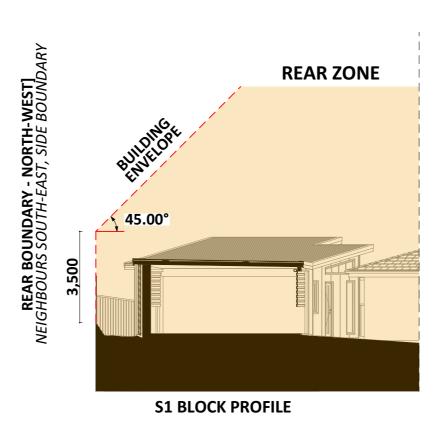

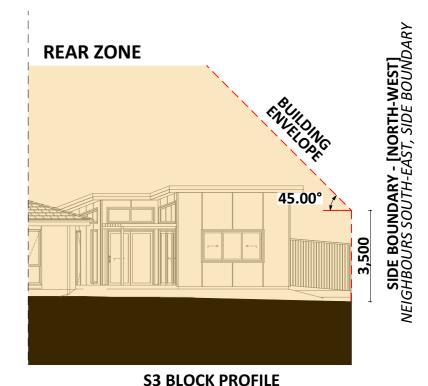

	CANBERRA GRANNY FLAT BUILDERS	PROJECT DETAIL Customer Name: Project Address: 4 Block № 32 Section № 24	Kate Inman and M		
	PROJECT TYPE	ARCHITECT	DESIGNER	TEMPLATE	BLOCK TYPE
(	CANBERRA GRANNY FLAT BUILDERS	LIKA	MONICA	v.19.4	LARGE

Proposed Structure GFA - Single Storey - Class 1 Proposed Structure GFA - Class 10 Proposed Roof Area - Class 1 Proposed Roof Area - Class 10 Actual POS [(GFA + Gar. GFA + Dr'way) - Block great Minimum Private Open Space (Block area x 0.60)


Site Coverage (LARGE | max 40%)

REV DESIGN PHASE DATE 63.92m2 18.94m2 P1.9 PROJECT PLAN 19/10/2023 76.97 m2 19.10 m2 CUSTOMER APPROVAL **747.00 m2** 38.47% 380 08 m2 SIGNATURE DATE

DRAWING NAME SOLAR AND BUILDING ENVELOPE DRAWING SCALE | SHEET SIZE DRAWING NUMBER CHECKLIST NUMBER 1:145 Α3 17 1101




**Sun-Winter - Jun 21 - 9:00 AM** 

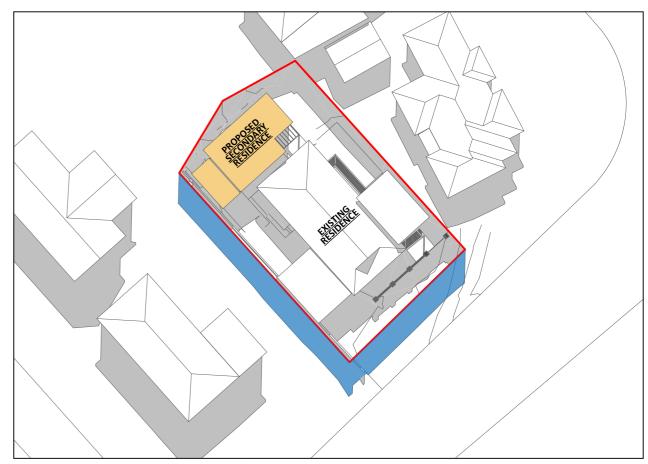

Sun-Winter - Jun 21 - 12:00 PM noon

**LEGEND:** 

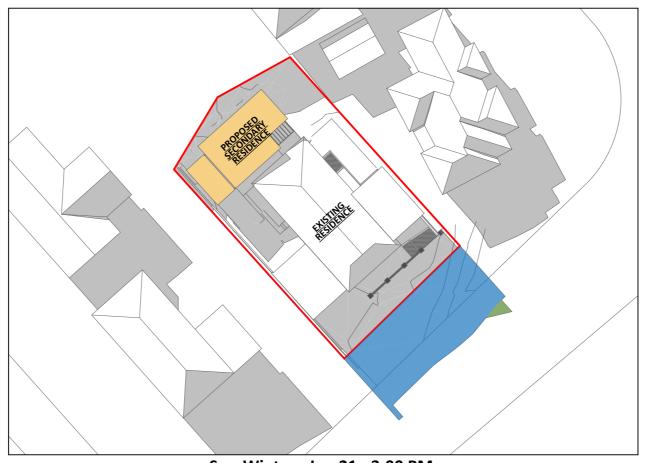

# Sun-Winter - Jun 21 - 3:00 PM

### **CANBERRA** Customer Name: Kate Inman and Matthew Sutherland Project Address: 4 Dungowan Street, Hawker ACT 2614 **GRANNY FLAT** Block № 32 Section № 24 **BUILDERS** PROJECT TYPE ARCHITECT DESIGNER TEMPLATE BLOCK TYPE CANBERRA GRANNY FLAT BUILDERS LIKA MONICA v.19.4 LARGE

PROJECT DETAILS

AREAS

Proposed Structure GFA - Single Storey - Class 1
Proposed Structure GFA - Class 10
Proposed Roof Area - Class 1
Proposed Roof Area - Class 10
Block Area
Actual Block Ratio Actual POS ((GFA + Gar. GFA + Dr'way) - Block area]
Minimum Private Open Space (Block area x 0.60)
Site Coverage (LARGE | max 40%)

	REV		DESIGN PHASE	DATE	DR
63.92m2 18.94m2	P1.9		PROJECT PLAN	19/10/2023	
76.97 m2 19.10 m2 47.00 m2	CUSTO	MER APPROVAL			
38.47%					DRA
80.08 m2 48.20 m2					
45.56 %		NAME	SIGNATURE	DATE	

# SHADOW OF PROPOSED STRUCTURES / ROOFS, CAST OUTSIDE OF CLIENT'S BLOCK RAWING NAME

CAN OVERLAP WITH THE EXISTING ROOF

AND ON THE CLIENTS BLOCK

THE ROOF AREA OF THE PROPOSED STRUCTURE. IN THE CASE OF AN ATTACHED EXTENSION, THE NEW ROOF

SHADOW OF THE EXISTING STRUCTURES IN THE AREA,

SHADOW OF A 2.40M HIGH SOLAR FENCE, CAST OUTSIDE OF THE CLIENTS BLOCK

SHADOW OF EXISTING STRUCTURES / ROOFS, CAST OUTSIDE OF CLIENT'S BLOCK

AWING SCALE | SHEET SIZE CHECKLIST NUMBER DRAWING NUMBER Α3 18 1101

**SHADOW DIAGRAM - WINTER** 





CANBERRA GRANNY FLAT BUILDERS

PROJECT DETAILS

Customer Name: Kate Inman and Matthew Sutherland

Project Address: 4 Dungowan Street, Hawker ACT 2614

Block № 32

Section № 24

ARCHITECT DESIGNER TEMPLATE BLOCK TYPE LARGE LIKA MONICA v.19.4

AREAS

Proposed Structure GFA - Single Storey - Class 1
Proposed Structure GFA - Class 10
Proposed Roof Area - Class 1
Proposed Roof Area - Class 10
Block Area
Actual Block Ratio
Actual POS [(GFA + Gar. GFA + Dr'way) - Block area]
Minimum Private Open Space (Block area x 0.60)
Site Coverage (LARGE | max 40%)

	REV		DESIGN PHASE	DATE	
63.92m2 18.94m2	P1.9		PROJECT PLAN	19/10/2023	
76.97 m2 19.10 m2 47.00 m2	CUSTO	MER APPROVAL			
38.47%					D
80.08 m2 48.20 m2					
40.ZU [[]Z	l .				

SIGNATURE

DRAWING NAME **SNAPSHOT 1** 

DRAWING SCALE | SHEET SIZE | DRAWING NUMBER CHECKLIST NUMBER Α3 19 1101





CANBERRA GRANNY FLAT BUILDERS

PROJECT DETAILS Customer Name: Kate Inman and Matthew Sutherland Project Address: 4 Dungowan Street, Hawker ACT 2614 Block No 32

Section № 24

DESIGNER ARCHITECT TEMPLATE BLOCK TYPE LIKA MONICA v.19.4 LARGE

AREAS

Proposed Structure GFA - Single Storey - Class 1
Proposed Structure GFA - Class 10
Proposed Roof Area - Class 1
Proposed Roof Area - Class 10
Block Area
Actual Block Ratio
Actual POS [(GFA + Gar. GFA + Dr'way) - Block area]
Minimum Private Open Space (Block area x 0.60)
Site Coverage (LARGE | max 40%)

63.92m2 18.94m2 76.97 m2 19.10 m2 **747.00 m2** 38.47% 380.08 m2 448.20 m2 45.56 %

REV DESIGN PHASE DATE P1.9 PROJECT PLAN 19/10/2023 CUSTOMER APPROVAL

SIGNATURE

NAME

DRAWING NAME SNAPSHOT 2

DRAWING SCALE | SHEET SIZE | DRAWING NUMBER CHECKLIST NUMBER А3 20 1101





PROJECT TYPE ARCHITECT DESIGNER TEMPLATE BLOCK TYPE
CANBERRA GRANNY FLAT BUILDERS LIKA MONICA v.19.4 LARGE

AREAS

Proposed Structure GFA - Single Storey - Class 1
Proposed Structure GFA - Class 10
Proposed Roof Area - Class 1
Proposed Roof Area - Class 1
Block Area
Actual Block Ratio
Actual POS ((GFA + Gar. GFA + Dr'way) - Block area]
Minimum Private Open Space (Block area x 0.60)
Site Coverage (LARGE | max 40%)

REV DESIGN PHASE DATE

63.92m2
18.94m2
76.97 m2
19.10 m2
747.00 m2
38.47%
380.08 m2
448.20 m2
45.56 %

NAME SIGNATURE DATE

DRAWING NAME

SNAPSHOT 3

DRAWING SCALE | SHEET SIZE | DRAWING NUMBER | CHECKLIST NUMBER | A3 | 21 | 1101





PROJECT TYPE ARCHITECT DESIGNER TEMPLATE BLOCK TYPE CANBERRA GRANNY FLAT BUILDERS LARGE LIKA MONICA v.19.4

AREAS

Proposed Structure GFA - Single Storey - Class 1
Proposed Structure GFA - Class 10
Proposed Roof Area - Class 1
Proposed Roof Area - Class 10
Block Area
Actual Block Ratio
Actual POS [(GFA + Gar. GFA + Dr'way) - Block area]
Minimum Private Open Space (Block area x 0.60)
Site Coverage (LARGE | max 40%)

	REV	DESIGN PHASE	DATE
63.92m2 18.94m2	P1.9	PROJECT PLAN	19/10/2023
76.97 m2 19.10 m2 <b>747.00 m2</b>	custor	MER APPROVAL	
38.47% 380.08 m2			

SIGNATURE

DRAWING NAME

**3D FLOOR PLAN** 

DRAWING SCALE | SHEET SIZE | DRAWING NUMBER CHECKLIST NUMBER Α3 22 1101





PROJECT TYPE ARCHITECT DESIGNER TEMPLATE BLOCK TYPE
CANBERRA GRANNY FLAT BUILDERS LIKA MONICA v.19.4 LARGE

AREAS

Proposed Structure GFA - Single Storey - Class 1
Proposed Structure GFA - Class 10
Proposed Roof Area - Class 1
Proposed Roof Area - Class 1
Block Area
Actual Block Ratio
Actual POS ((GFA + Gar. GFA + Dr'way) - Block area]
Minimum Private Open Space (Block area x 0.60)
Site Coverage (LARGE | max 40%)

REV DESIGN PHASE DATE

63.92m2
18.94m2
76.97 m2
19.10 m2
747.00 m2
38.47%
380.08 m2
448.20 m2
45.56 %

NAME SIGNATURE DATE

DRAWING NAME

3D SECTION - VIEW 1

DRAWING SCALE | SHEET SIZE | DRAWING NUMBER | CHECKLIST NUMBER | A3 | 23 | 1101